

#### **DEVELOPMENT VARIANCE PERMIT**

Application / File No.: 0067-24-DVP-END

To: Mathew Isabelle

Champlain Holdings Inc.

Address: 704 Cliff Avenue, Enderby BC

1. This Development Variance Permit is issued in accordance with the provisions of Section 498 of the Local Government Act and subject to compliance with all of the Bylaws of the City of Enderby applicable thereto, except as specifically varied by this permit.

2. This Development Variance Permit applies to and only to those lands within the City of Enderby described below, and any and all buildings, structures, and other development thereon:

Legal Description:

LOT 1 DISTRICT LOT 150 KAMLOOPS (FORMERLY OSOYOOS) DIVISION YALE DISTRICT PLAN EPP115678

PID:

031-940-846

Civic Address:

704 Cliff Avenue, Enderby BC

- 3. City of Enderby Zoning Bylaw No. 1550, 2014 is hereby supplemented or varied as follows:
  - Section 309.3.a.i by not requiring a 2 m (6.562 foot) landscaped buffer area along the southern property boundary where it abuts a residential lot, as shown on the attached Schedule 'A';
  - Section 401.2 by increasing the maximum number of principal buildings on the lot from 1 to 2, as shown on the attached Schedule 'A';
  - Section 401.3 by increasing the minimum floor area for a two-bedroom dwelling unit from 45 m2 (484.4 square feet) to 44.59 m2 (480 square feet), as shown on the attached Schedule 'A';
  - Section 401.3 by permitting the gross floor area of dwelling units located on the first storey level and entirely behind the commercial use to exceed the gross floor area of the commercial use on the first storey level, as shown on the attached Schedule 'A':
  - Section 401.10.c by reducing the minimum rear yard setback from 6 m (19.68 feet) to 1.5 m (4.92 feet), as shown on the attached Schedule 'A';

- Section 401.11.d.iii by permitting dwelling units to be located in a standalone building, as shown on the attached Schedule 'A';
- Section 901.2.a by reducing the minimum length for an off-street parking space from 6 m (19.68 feet) to 5.5 m (18.04 feet), as shown on the attached Schedule 'A';
- Section 901.2.b by reducing the minimum width of an unobstructed maneuvering aisle for right angle parking from 8 m (26.25 feet) to 7 m (22.97 feet), as shown on the attached Schedule 'A'; and
- Section 901.3 by reducing the minimum number of off-street parking spaces from 11 to 9, as shown on the attached Schedule 'A'.
- 4. City of Enderby Subdivision Servicing and Development Bylaw No. 1278, 2000 is hereby supplemented or varied as follows: **N/A**
- 5. Requirements, conditions or standards applicable to Section 491 of the Local Government Act: **N/A**
- 6. As a condition of the issuance of this Permit, the Council is holding the security set out below to ensure that development is carried out in accordance with the terms and conditions of this Permit. Should any interest be earned upon the security, it shall accrue to the Permittee and be paid to the Permittee if the security is returned. The condition of the posting of the security is that should the Permittee fail to carry out the development hereby authorized, according to the terms and conditions of this Permit within the time provided, the City of Enderby may use the security to carry out the work by its servants, agents, or contractors, and any surplus shall be paid over to the Permittee, or should the Permittee carry out the development permitted by this Permit within the time set out above, the security shall be returned to the Permittee. There is filed accordingly:
  - a. a Bearer Bond in the amount of \$ N/A; or
  - b. a Performance Bond in a form acceptable to the City of Enderby in the amount of \$ N/A; or
  - c. an Irrevocable Letter of Credit in the amount of \$ N/A; or
  - d. a certified cheque in the amount of \$ N/A.
- 7. The land described herein shall be developed strictly in accordance with the terms and conditions and provisions of this Permit and any plans and specifications attached to this Permit which shall form a part hereof.
- 8. If the Permittee does not commence the development permitted by this Permit within two (2) years of the date of issuance of this Permit, this Permit shall lapse.
- 9. This Permit is not a Building Permit.

AUTHORIZING	RESOLUTI	ON PASSED BY COUNCIL THE	DAY OF	, 2024.
ISSUED THIS	DAY OF	, 2024.		

Corporate Officer

NOTICE OF PERMIT:

Issued	
Amended	
Cancelled	

Filed with the Land Title Office this  $\;$  day of  $\;$  , 2024.

#### THE CORPORATION OF THE CITY OF ENDERBY


# DEVELOPMENT VARIANCE PERMIT APPLICATION SUBJECT PROPERTY MAP


File: 0067-24-DVP-END (Isabelle)

Applicant: Mathew Isabelle

Owner: Champlain Holdings Inc.

Location: 704 Cliff Avenue, Enderby BC

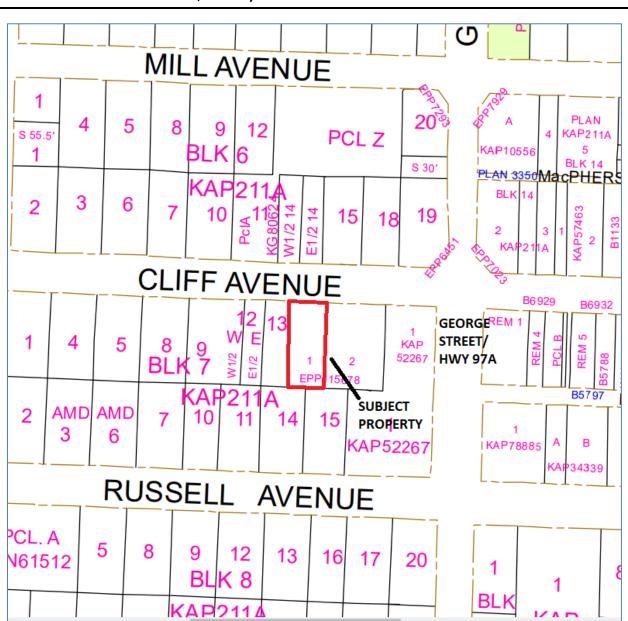

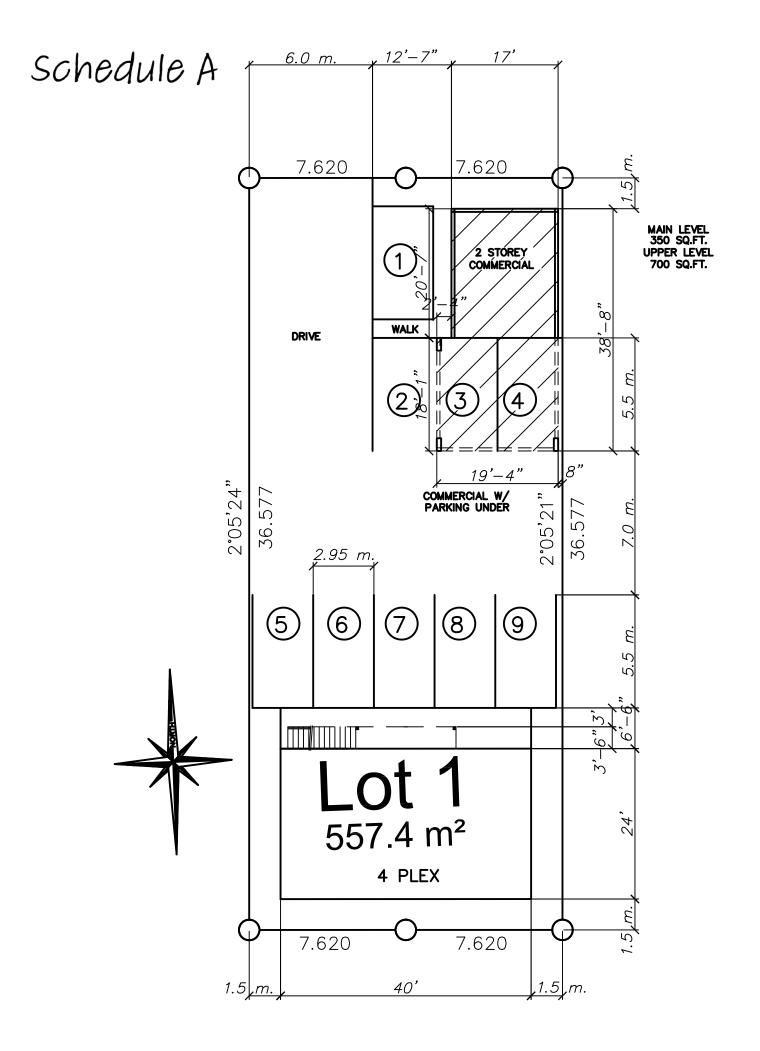



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REFERENCE: CUSTOM

DRAWN:

CHECKED: TB

DATE: FEB ' 24

SCALE:
AS NOTED
SHEET:

1A
PLAN NUMBER:



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REFERENCE: CUSTOM

> DRAWN: AD

AD CHECKED:

REMOVAL OF JHDL LOGO, TITLE BLOCK OR WATER MARK IS AGAINST

SOME BEAMS & LINTELS MAY BE REQUIRED TO BE ENGINEERED

IN THE BUILDING CODE & IS THE RESPONSIBILITY OF THE HOME OWNER

OR BUILDER TO SECURE.

DUE TO ROOF LOADS NOT COVERED

CANADIAN COPYRIGHT LAWS

NOTE:

TB DATE:


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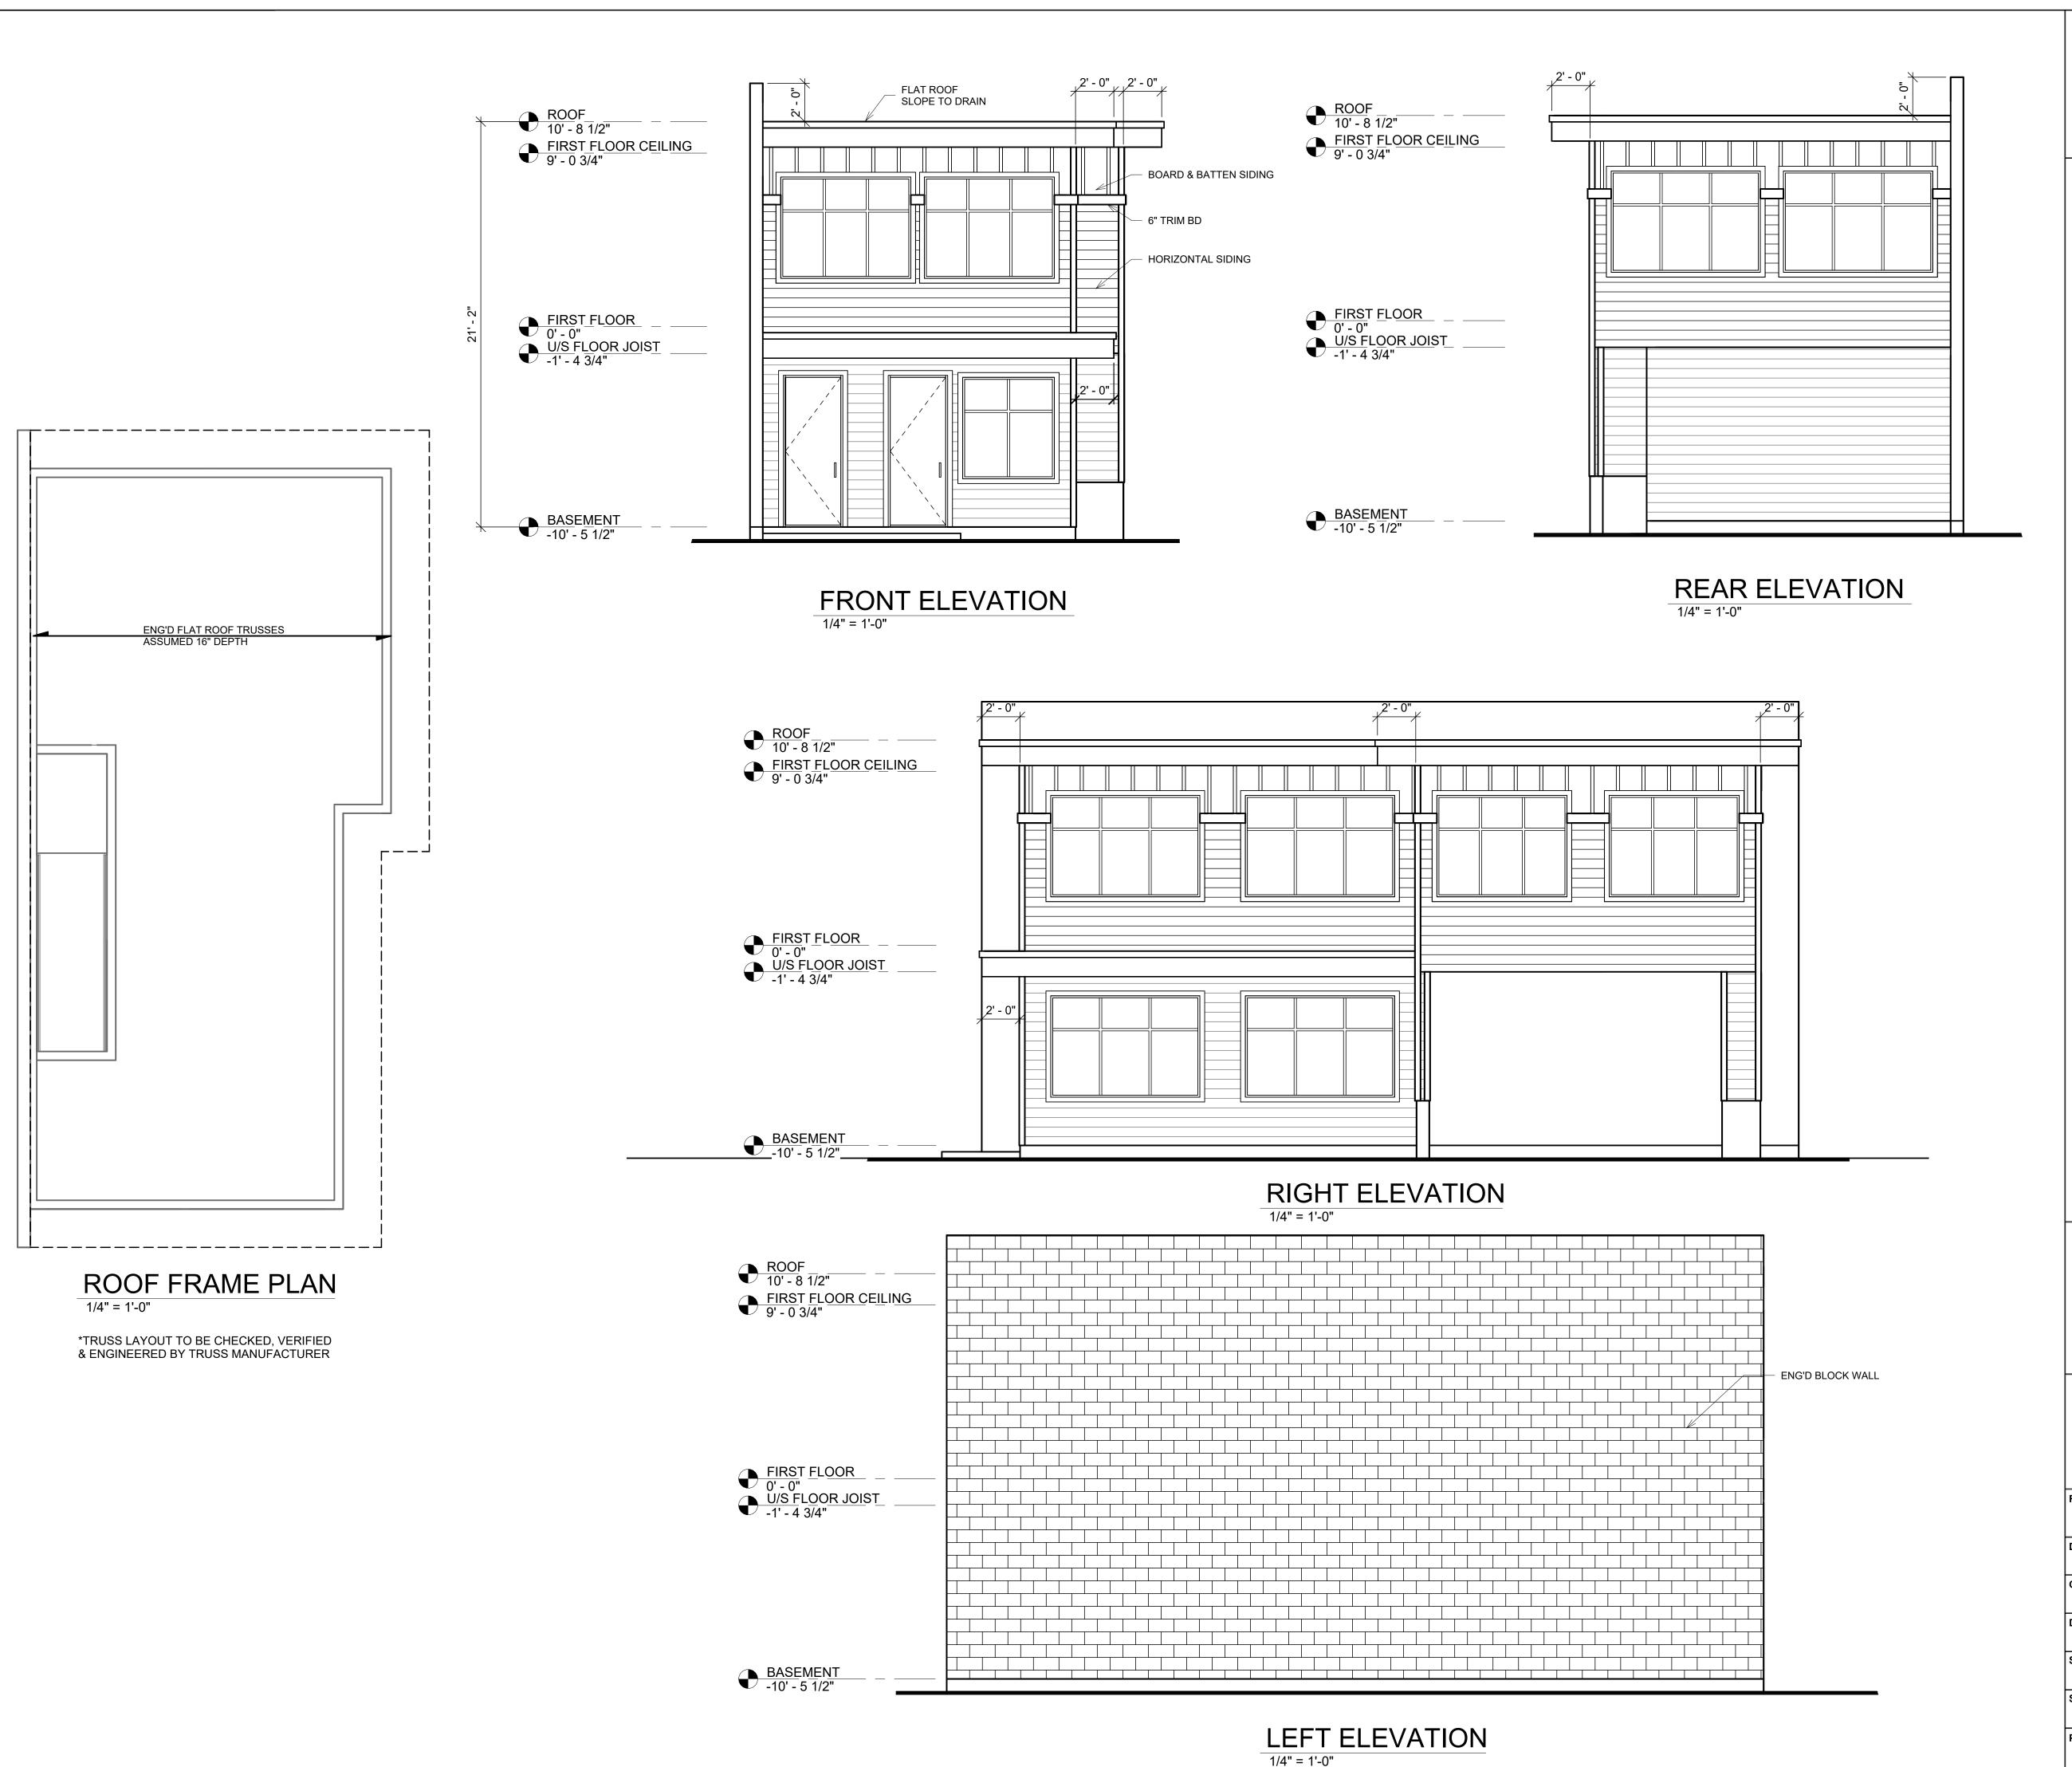
SCALE: AS NOTED

SHEET:

1 OF 3
PLAN NUMBER:

C8-2-115



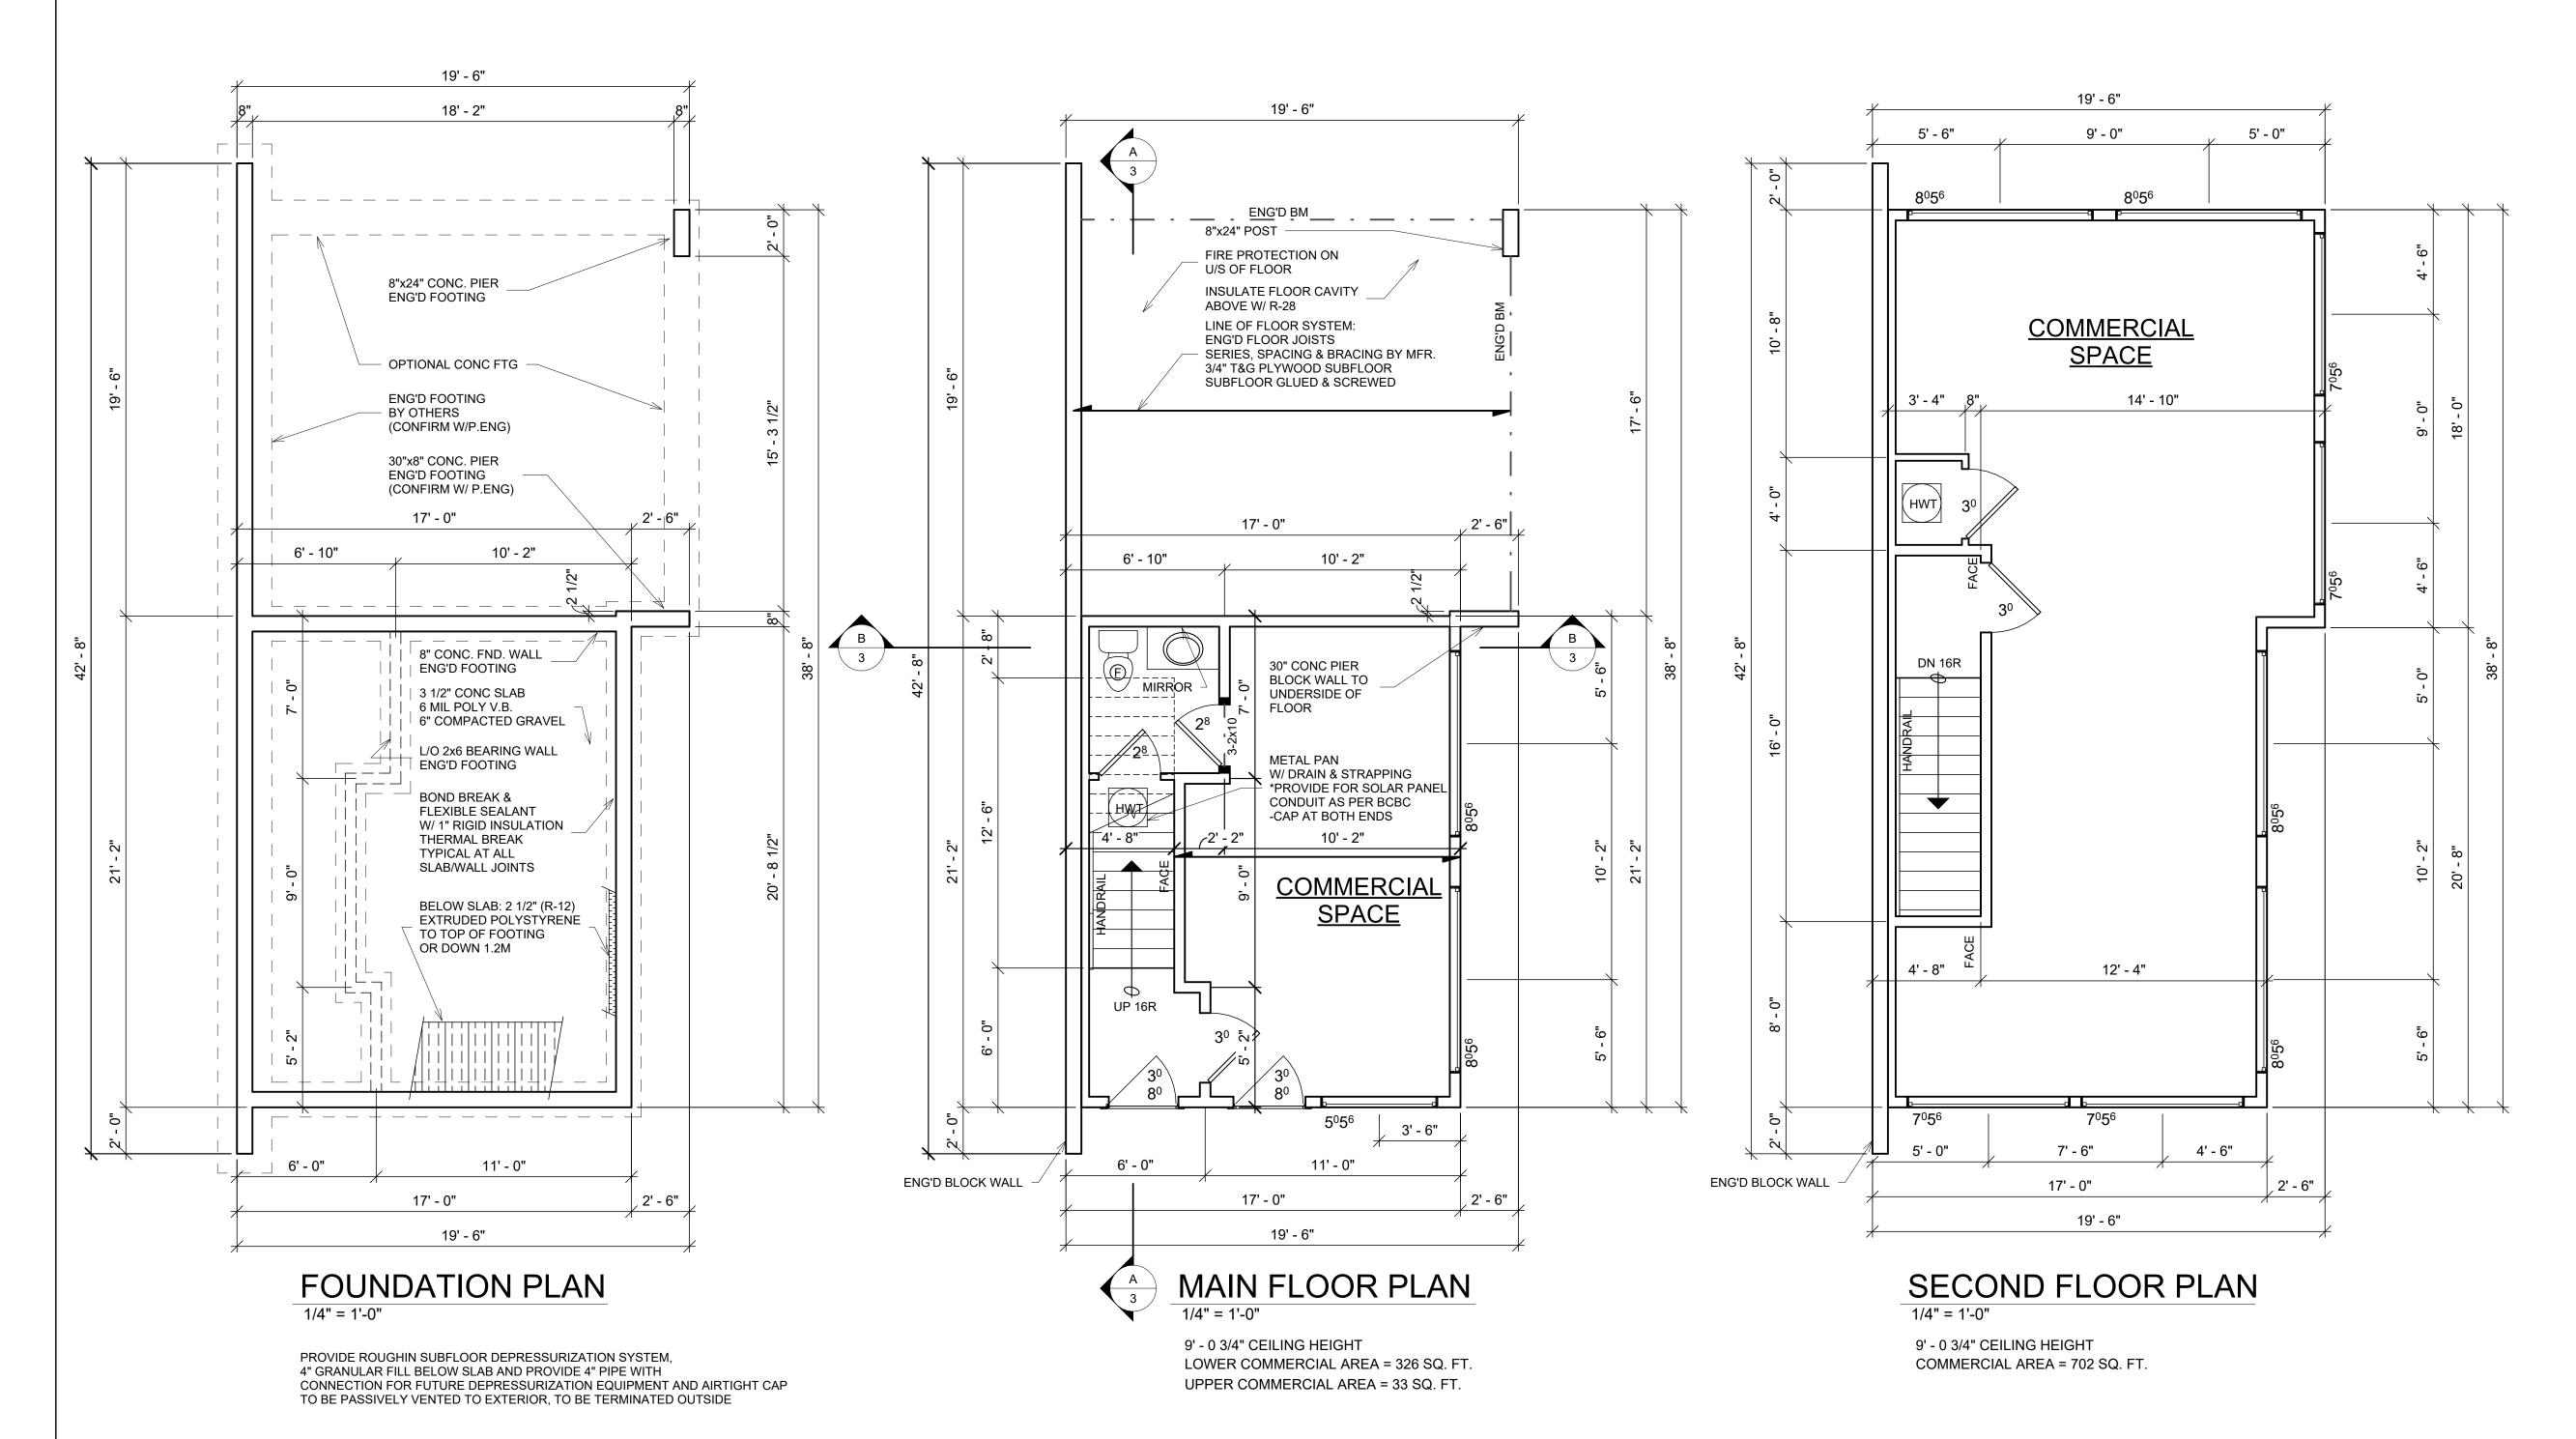

201-1658 COMMERCE AVE KELOWNA, B.C., V1X 8A9 (236) 420-3346 TOLL FREE 1-888-458-9235

201-16 KELOV (236) 4 TOLL I

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REFERENCE: CUSTOM


DRAWN: AD

CHECKED: TB

DATE: FEB ' 24

SCALE:
AS NOTED
SHEET:

2 OF 3 PLAN NUMBER

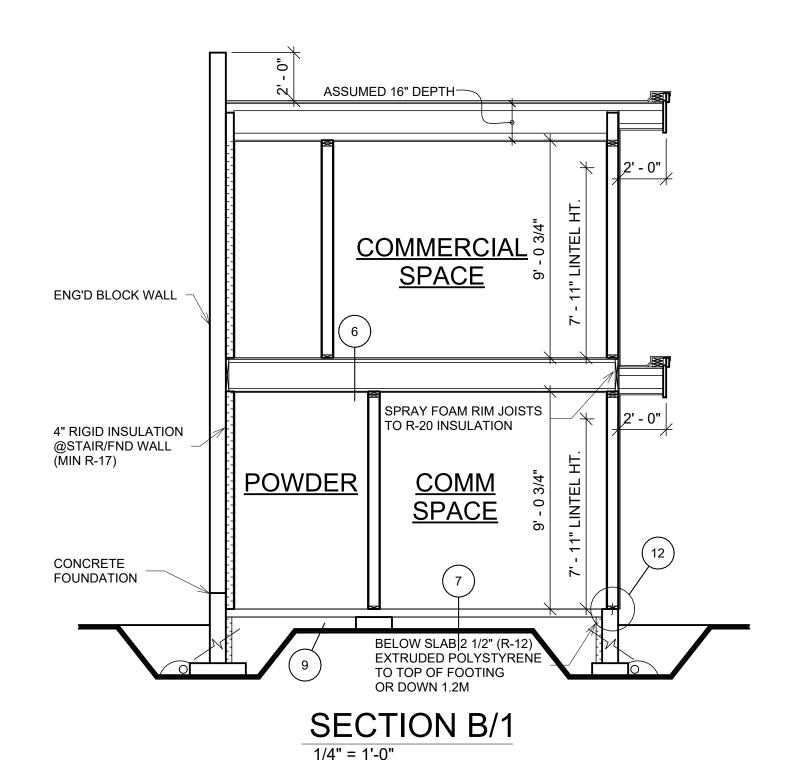

## **SPECIFICATIONS**

FLAT ROOF: TORCH ON ROOFING W/ SLOPE TO DRAINS 1/2" PLY SHEATHING WITH 'H' CLIPS ENG'D ROOF TRUSSES

CEILING: 5/8" GYPSUM BOARD 6 MIL POLY V.B. (U.V. RESISTANT)

R-50 BATT INSULATION

FASCIA/SOFFIT ALUMINUM GUTTER ON 2x10 FASCIA BOARD VENTED ALUM. SOFFIT

**EXTERIOR WALL:** HORIZONTAL/BOARD & BATTEN SIDING **BUILDING PAPER** 7/16" PLY SHEATHING 2x6 STUDS @ 24" o/c R-24 BATT INSULATION 6 MIL. POLY V.B. (U.V. RESISTANT)

**INTERIOR PARTITION:** 1/2" GYPSUM BOARD - EACH SIDE 2x6 STUDS @ 16" o/c

1/2" GYPSUM BOARD

SECOND FLOOR: FINISH FLOORING 3/4" T&G PLYWOOD SUBFLOOR SCREWED & GLUED **ENGINEERED FLOOR JOISTS** SIZE & SPACING BY MANUFACTUERER MAIN FLOOR: 3 1/2" CONC. SLAB 6 MIL. POLY. 6" COMPACTED GRAVEL

**EXTERIOR FOUNDATION:** 2 COATS ASPHALT EMULSION 8" CONC FOUNDATION WALL 2 1/2" (R-12) EXTRUDED POLYSTYRENE DOWN 1.2 M OR TO TOP OF FOOTING 18" x 6" CONCRETE FOOTING

INTERIOR FOUNDATION: 2x6 STUDS @ 16" o/c ON 45 # FELT OR EQUIVALENT 1/2" DIA ANCHOR BOLTS @ 5'-6" o/c 16" x 6" CONCRETE FOOTING

DRAINAGE: 6" MIN. DRAIN ROCK COVER 4" DIA. DRAIN TILE

STAIRS: 16 EQUAL RISERS 10" RUNS W/ 1" NOSING 2x10 STRINGERS 34" HIGH HANDRAIL 6'-6 3/4" MIN. HEADROOM

PLATE TO FOUNDATION CONNECTION: 1/2" DIAM. ANCHOR BOLTS @ 5'-6" O.C. 2x6 PLATE ON 45# FELT OR APPROVED DAMPPROOFING

ENGINEER'S ADDENDUMS, STRUCTURAL DETAILS, AND NOTES SUPERCEDE THOSE NOTED ON THIS GENERAL NOTE SHEET DEPENDING ON LOCAL CONDITIONS.

## **GENERAL NOTES**

## STANDARD NOTES

THE FOLLOWING NOTES ARE TO BE INCLUDED WITH AND BECOME PART OF THE ATTACHED PLANS. BY COMMENCING CONSTRUCTION OF A BUILDING FROM THESE PLANS. THE OWNER AND/OR BUILDER ACCEPTS THESE PLANS AS

DRAWN AND HAS READ AND UNDERSTANDS THE GENERAL NOTES AS FOLLOWS THIS DRAWING WAS PREPARED IN ACCORDANCE WITH THE CURRENT EDITION OF THE BC BUILDING CODE. IT IS THE RESPONSIBILITY OF THE OWNER/BUILDER TO INSURE THAT SUBSEQUENT CHANGES TO THE CODE ARE COMPLIED WITH AND INCORPORATED IN THE CONSTRUCTION OF THIS PLAN. ALL WORK

SHALL CONFORM TO THE CURRENT BC BUILDING CODE AND/OR LOCAL BUILDING CODES AND BYLWAS THAT MAY TAKE PRECEDENCE.

ALL WORK SHALL BE EQUAL IN ALL RESPECTS TO GOOD BUILDING PRACTICE.

WRITTEN DIMENSIONS TAKE PRECEDENCE OVER SCALED DRAWINGS. JENISH HOUSE DESIGN LIMITED SHALL NOT BE RESPONSIBLE FOR ANY VARIANCES FROM THE STRUCTURAL DRAWINGS AND SPECIFICATIONS, OR ADJUSTMENTS REQUIRED RESULTING FROM CONDITIONS ENCOUNTERED AT THE JOB SITE AND IS THE SOLE

RESPONSIBILITY OF THE OWNER OR CONTRACTOR. CONSTRUCTION LOADS ON THE STRUCUTRE CAUSED BY INTERIM STORAGE OF MATERIALS OR USE OF EQUIPMENT SHALL NOT BE ALLOWED TO EXCEED THE DESIGN LOAD. THE BUILDER SHALL BE RESPONSIBLE FOR MAINTAINING A NEAT AND ORDERLY CONSTRUCTION SITE AT ALL TIMES.

AT END OF CONSTRUCTIONTHE BUILDER SHALL BE RESPONSIBLE FOR CLEANING THE JOB SITE AND BUILDING(S) OF ANY REFUSE AND MAKING GOOD ANY DAMAGE TO BUILDING(S) INCURRED DURING CONSTRUCTION. PRIOR TO COMMENCING EXCAVATION WORK THE BUILDER SHALL

BE RESPONSIBLE FOR ESTABLISHING THE LOCATION OF AND CLEARLY MARKING EXISTING SERVICES AND IMMEDIATELY NOTIFYING APPLICABLE AUTHORITIES OF ANY DISCREPANICES. TOPSOIL AND EXCAVATED MATERIAL TO BE STOCKPILED SEPARATELY ON SITE.

### **ERRORS AND OMISSIONS**

JENISH HOUSE DESIGN LIMITED MAKES EVERY EFFORT TO PROVIDE COMPLETE AND ACCURATE HOME PLANS. HOWEVER. WE ASSUME NO LIABILITY FOR ANY ERROS OR COMISSIONS THAT MAY AFFECT CONSTRUCTION. IT IS THE RESPONSIBILITY OF THE BUILDER TO CHECK AND VERIFY ALL DIMESNIONS AND DETAILS BEFORE PROCEEDING WITH CONSTRUCTION. SHOULD ANY DISCREPANCIES BE FOUND ON THE PLANS PLEASE ADVISE OUR OFFICE AT YOUR EARLIEST CONVENIENCE, BY DOING SO WE WILL BE ABLE TO MAKE CORRECTIONS TO THE DRAWINGS AND REPLACE ANY PLANS PURHCASED IF NECESSARY. IN THIS WAY WE CAN BETTER SERVE YOU AND PREVENT ERROS FROM

## STRUCTURAL DESIGN AND ENGINEERING

TO PROVIDE OUR CLIENTS WITH DISTINCTIVE AND ATTRACTIVE DESIGNS IT HAS BEEN NECESARY IN SOME INSTANCES TO USE BEAM SIZES AND FRAMING DETAILS NOT SPECIFIED IN PART NINE OF THE B.C. BUILDING CODE. THE CITY OR MUNICIPAL BUILDING DEPARTMENT MAY REQUIRE CONFIRMATION BY A CERTIFIED STRUCTURAL ENGINEER WHICH IS THE RESPONSIBILITY OF OWNER OR BUILDER TO PROVIDE.

## STRUCTURAL DESIGN CRITERIA

ASSUMED ROOF DESIGN LOAD (LIVE AND DEAD) - 50 POUNDS PER SQUARE FOOT (2.5 KN/M.SQ.). ASSUMED SOIL BEARING CAPACITY - 2,500 P.S.F.

(119.7 KN/M.SQ.) CONCRETE FOUNDATIONS AND SLABS ON GRADE TO HAVE A MINIMUM COMPRESSIVE STRENGTH OF 20 MPA AT 28 DAYS. FRAMING LUMBER TO BE #2 S.P.F. AND BETTER UNLESS OTHERISE NOTED. BEAMS TO BE #2 S.P.F. AND BETTER.

IF SOIL CONDITIONS ARE LESS, OR FLOOR AND ROOF LOADS ARE GREATER THAN THIS PLAN IS DESIGNED FOR, YOUR BUILDING DEPARTMENT MAY REQUIRE ADJUSTMENTS TO THE PLANS OR ASK THAT THE PLANS BE ENGINEERED BY A CERTIFIED STRUCTURAL ENGINEER. IT IS BEST THAT AN ENGINEER FAMILIAR WITH LOCAL CONDITIONS BE CONSULTED.

## SITE PLAN NOTES

IF A SITE PLAN IS NOT PROVIDED BY JENISH HOUSE DESIGN LIMITED, THE OWNER OR BUILDER SHALL BE RESPONSIBLE FOR THE CORRECT SITING OF THIS HOME ON THE PROPERY. JENISH HOUSE DESIGN LIMITED ASSUMES NO LIABILITY FOR PLANS COMPLYING WITH ZONING REGULATIONS OR LOT CONDITIONS. OWNER SHALL SUPPLY ANY MISSING INFORMATION ON SITE PLAN, I.E. DIMENSIONS, ELEVATIONS OF LOT, LEGAL DESCRIPTION, SITE ADDRESS, NORTH DIRECTION, AND LOCATION OF SERVICES, EASEMENTS AND RIGHT OF WAYS, ALL MEASUREMENTS ON SITE PLAN TO BE GOVERNED AND APPROVED BY AUTHORITIES HAVING JURISDICTION BEFORE STARTING CONSTRUCTION. WELLS AND SEPTIC DISPOSAL SYSTEMS TO BE LOCATED AND CONSTRUCTED IN ACCORDANCE WITH HEALTH AUTHORITIES HAVING JURISDICTION.

## **ELECTRICAL**

INSTALLATION OF ELECTRICAL ITEMS MUST COMPLY WITH THE BC ELECTRICAL CODE AND REGULATIONS AND WITH THE LOCAL ELECTRIC POWER SUPPLIER'S REGULATIONS IN ALL RESPECTS. ELECTRICAL OUTLET LOCATIONS SHOWN ON PLANS COMPLY WITH OR EXCEED CURRENT BUILDING CODE MINIMUM REQUIREMENTS AND ARE TO BE USED AS A GUIDE ONLY. ADJUST

ACCORDING TO OWNER'S REQUIREMENTS.

### **FOUNDATIONS**

FOUNDATIONS SHALL BE CONCRETE ON SOLID UNDISTURBED

BEARING AND BELOW FROST LINE. FOUNDATION WALLS SHALL NOT BE BACK FILLED UNTIL CONCRETE HAS REACHED ITS SPECIFIED 28-DAY STRENGTH AND THE FLOOR SYSTEM INCLUDING SHEATHING HAS BEEN INSTALLED

OR UNTIL ADEQUATELY BRACED SUBJECT TO APPROVAL BY AUTHORITY HAVING JURISDICTION. GRADES SHOW ON PLANS ARE ESTIMATED. FOUNDATION WALL HEIGHTS MAY REQUIRE ADJUSTMENT TO SUIT SITE CONDITIONS. ALL CONCRETE AND MASONRY FOUNDATION WALLS EXCEEDING HEIGHT LIMITS SPECIFIED BY CURRENT BUILDING CODES REQUIRE

ENGINEERING. PERIMETER DRAINAGE SHALL BE INSTALLED WHERE REQUIRED TO THE APPROVAL OF LOCAL AUTHORITIES.

IT IS RECOMMENDED THAT ALL FOUNDATION WALLS 24" (600 MM) AND HIGHER SHALL HAVE ONE 12MM (1/2" DIAMETER) REINFORCING BAR CENTERED 3" FROM TOP. CORNER REINFORCING TO BE LAPPED MINIMUM 24".

### WOOD FRAMING

DIMENSIONS ARE FROM OUTSIDE FACE OF EXTERIOR STUDS TO CENTER OF PARTITION WALLS UNLESS OTHERWISE NOTED. FACE OF EXTERIOR STUD WALL AND FOUNDATION WALL TO BE FLUSH. JOISTS SHALL BE DOUBLED UNDER PARALLEL PARTITIONS OVER 6'-0" LONG. JOISTS TO BE PLACED TO ACCOMMODATE HEATING. PLUMBING, ETC. ALL LINTELS SHALL BE 2 - 2 X 10'S UNLESS OTHERWISE NOTED.

WOOD IN CONTACT WITH CONCRETE TO BE DAMP-PROOFED WITH 45 LBS FELT 6 MIL POLY OR OTHER APPROVED METHOD PLATES TO BE ANCHORED TO CONCRETE WITH 1/2" DIAMETER ANCHOR BOLTS AT MAXIMUM 6'-0" O/C. OR OTHER APPROVED METHOD. EXTERIOR CONCRETE SILL PLATES TO BE LEVEL AND UNDERSIDE SEALED.

FLOOR JOISTS AND ROOF JOISTS WITH SPANS MORE THAN 7'-0" SHALL BE CROSSBRIDGED AT MID SPAN OR AT 7'-0" O/C MAXIMUM UNLESS SHEATHED OR STRAPPED BOTH SIDES WITH WOOD. BRIDGING SHALL BE 2 X 2 DIAGONAL TYPE WHEREVER POSSIBLE ROOF TRUSSES REQUIRE ENGINEER'S CERTIFICATE. FOR PREFABRICATED TRUSSES OBTAIN CERTIFICATE FROM

## INSULATION AND VENTILATION

MANUFACTURER.

MINIMUM INSULATION REQUIREMENTS: ROOF (ATTIC) R-50 (R.S.I. - 8.45) ROOF/CEILING (SLOPING) (R.S.I. - 4.93) R-28 R-24 (R.S.I. - 3.87) WALLS INSULATION REQUIREMENTS 4500 DEGREE DAYS OR GREATER R-60 (R.S.I. - 10.56)

6 MIL ULTRAVIOLET RESISTANT POLY AIR BARRIER SHALL BE INSTALLED ON THE WARM SIDE OF INSULATION. ALL ROOF SPACES SHALL BE VENTILATED WITH SOFFIT, ROOF, OR GABLE VENTS, OR A COMBINATION OF THESE EQUALLY DISTRIBUTED BETWEEN TOP OF ATTIC SPACE AND OVERHANG

PROVIDE BAFFLE FOR AIR SPACE (EQUAL TO SOFFIT VENTING) BETWEEN INSULATION AND ROOF SHEATHING AT EXTERIOR WALL

#### ATTICS OR ROOF SPACES TO BE VENTED MINIMUM 1/300 OF AREA. UNHEATED CRAWLSPACES TO BE VENTED MINIMUM 1/500 OF AREA WITH CLOSEABLE VENTS.

## **FINISHING**

OWNER SHALL SPECIFY ALL INTERIOR AND EXTERIOR FINSHING. OWNER SHALL CONFIRM ANY FINISHING SHOWN ON PLANS. EXTERIOR DOORS SHALL BE SOLID CORE/INSULATED AND WEATHER-STRIPPED. GARAGE DOORS TO DWELLING TO BE AS ABOVE AND SELF-CLOSING. FLASH AT ALL HORIZONTAL CHANGES IN EXTERIOR FINISHING CAULK AROUND ALL EXTERIOR OPENINGS. FLASH OVER ALL UNPROTECTED OPENINGS.

WINDOW SIZES ARE SHOWN IN FEET AND INCHES. I.E.  $4^{\circ}3^{\circ} = 4'-0"$  WIDE BY 3'-6" HIGH. DOOR SIZES ARE WIDTH SHOWN BY 6'-8" HIGH.

I.E. 28 = 2'-8" WIDE BY 6'-8" HIGH. OPENINGS IN PARTITIONS SHOWN WITHOUT DOORS ARE FULL HEIGHT UNLESS SHOWN AS AN ARCH. ARCHES ARE FRAMED 7'-0" HIGH UNLESS OTHERWISE NOTED.

COAT AND CLOTHES CLOSETS SHALL HAVE ONE ROD AND SHELF. LINEN CLOSETS SHALL HAVE 5 ADJUSTABLE SHELVES WHERE POSSIBLE, BROOM CLOSETS SHALL HAVE ONE SHELF. ALL BATHROOMS SHALL HAVE A WALL MEDICINE CABINET OR ONE LOCKABLE DRAWER.

INSTALLATION OF ENTIRE HEATING SYSTEM MUST COMPLY WITH MANUFACTURER'S DIRECTIONS (WHERE APPLICABLE) AND CONFORM WITH LOCAL CODES AND REGULATIONS IN ALL

RESPECTS GAS CONNECTION WILL REQUIRE SEPARATE PERMIT AND INSPECTION

FUEL BURNING APPLIANCES, INCLUDING FURNACES, FIREPLACES AND STOVES, TO BE PROVIDED WITH COMBUSTION AIR SUPPLY FROM EXTERIOR.

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## FLECTRICAL SYMBOLS

ELECTRICAL STINDOLS				
DESCRIPTION SYMBOL DESCRIPTION SYMBOL DESC	CRIPTION This drawing is the			
DUPLEX RECEPTACLE (NUMBER INDICATES HEIGHT ABOVE FLOOR IF OTHER THAN 12")	reproduced or used in			
DPPED LIGHT FIXTURE  SINGLE RECEPTACLE  DOOR CHIMES	permission from same			
LING FAN QUAD RECEPTACLE				
DUPLEX RECEPTACLE SWITCHED ONE SIDE IIC REMOTE INTE	REFERENCE:			
CESSED WALL WASHER DUPLEX RECEPTACLE - SPLIT CIRCUIT TELEVISION C	CABLE OUTLET CUSTOM			
POUR PROOF LIGHT FIXTURE	DRAWN:			
SMOKE DETECTION OF THE CONTROL OF TH	CTOR AND ALARM AD			
208/230 VOLT FOR RANGE, OVEN, AND DRYER ETC 30 OR 40 AMP	SYMBOLS CHECKED:			
T FAN DUPLEX APPLIANCE OUTLET (A) CLASS A META	AL CHIMNEY			
DUPLEX RECEPTACLE WEATHER PROOFED. ALL W.P. OUTLETS ALSO TO HAVE G.F.I. PROTECTION.  B CLASS B META	DATE: FEB ' 24			
DUPLEX RECEPTACLE WITH GROUND FAULT INTERRUPTER CIRCUIT  GFI BREAKER  HOSE BIB	SCALE: AS NOTED			
GLE FLUORESCENT FIXTURE \$ SINGLE POLE SWITCH	SHEET:			
ORESCENT LIGHT PATORE \$ 3 OR 4 WAY SWITCH  BEAM OR GIRL	POST IN WALL SUPPORTING REPERTURSS. (WIDTH OF AS STRUCTURAL MEMBER			
\$ DIMMER CONTROL SWITCH SUPPORTED)				
SESSED \$ DOOR SWITCH FLOOR CEILING WALL	<u>↓</u> C8-2-115			
\$ TIMER WARM AIR REGISTERS	RETURN AIR REGISTER			

TB
DATE:
JANUARY ' 24

SCALE: AS NOTED

SHEET: 1A





HEAD OFFICE:
201-1658 COMMERCE AVE
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SHEET: 2 OF 3